DRAWINGS TO BE READ IN CONJUNCTION WITH DOCUMENT FA-R-20-17 - SPECIFICATION. ALL DRAWINGS TO BE READ IN CONJUNCTION WITH STRUCTURA DO NOT SCALE FROM THIS DRAWING LANDSCAPING INDICATIVE ONLY AND SUBJECT TO A FULL ALL WORKS TO BE CARRIED OUT IN ACCORDANCE WITH THE UNLESS OTHERWISE NOTED, DIMENSIONS ARE SHOWN TO STRUCTURE ALL DIMENSIONS TO BE CHECKED ON SITE THE CLIENT MUST ABIDE BY THEIR DUTIES AS DEFINED WITHIN THE BUILDING SAFETY ACT 2022 WHICH RELATE TO ANY BUILDING WORKS. BUILDING SAFETY ACT **CDM REGULATIONS** THE CLIENT MUST ABIDE BY THE CONSTRUCTION DESIGN AND MANAGEMENT REGULATIONS 2015 WHICH RELATE TO ANY BUILDING WORKS WHICH: (a) LASTS LONGER THAN 30 WORKING DAYS AND HAS MORE THAN 20 WORKERS WORKING SIMULTANEOUSLY AT ANY POINT IN THE PROJECT. (b) EXCEEDS 500 PERSON DAYS. N.B THIS LIST IS NOT EXHAUSTIVE AND THE PC (PRINCIPAL CONTRACTOR) HAS A DUTY TO CO-OPERATE, COMMUNICATE AND CO-ORDINATE WITH THE PD (PRINCIPAL DESIGNER) AND DESIGN TEAM AND COMPILE A COMPREHENSIVE RISK REGISTER WITH METHODS OF WORK STATEMENTS AT THE DESIGN STAGE PRIOR TO COMMENCEMENT OF WORK ON SITE. RISKS SHALL BE ANTICIPATED, REDUCED AND OR AVOIDED WHERE POSSIBLE. THIS LIST SERVES TO HIGHLIGHT KEY RISKS IDENTIFIED BY THE DESIGN TEAM AND PD IN THE CONSTRUCTION, USE AND MAINTENANCE OF THE BUILDING. REFER TO DESIGNERS CDM HAZARD IDENTIFICATION AND ANALYSIS AND OPTION MATRIX FOR FURTHER INFORMATION CDM - RISK REGISTER ADEQUATE PROVISION OF SAFE ACCESS VIA SCAFFOLDING DURING THE WORKS, WORKING AT HEIGHT RULES TO BE OBSERVED DURING CONSTRUCTION PHASE AND FOR ALL ROUTINE ROOF MAINTENANCE INCLUDING GUTTER 2. HAZARD - FALLING OBJECTS CONSTRUCTION WORKERS TO BE PROTECTED FROM FALLING OBJECTS FROM WORKS TO ROOF DURING THE CONSTRUCTION HAZARD - COLLAPSING STRUCTURE TEMPORARY WORKS AND RESTRAINTS REQUIRED TO PROPOSEI RETAINING WALLS DURING THE CONSTRUCTION WORKS. Manual lifting rules to be observed when assessing weights of construction materials. If block work exceeds 20kg, 2 x man lift required, PC and sub-contractor to carry out risk assessment prior to 5. HAZARD - GLAZING PANELS CONSTRUCTION & MAINTENANCE - NEW GLAZING WILL REQUIRE ROUTINE MAINTENANCE/CLEANING. IT IS CONSIDERED THAT THE HEIGHT OF THE GLAZING IS WITHIN THE LIMITS OF EXTENDABLE WINDOW CLEANING EQUIPMENT AND IT IS THEREFORE FORESEEN THAT WINDOW CLEANING OPERATIVE

WILL CARRY OUT THE WORK FROM GROUND LEVEL. WHERE HEIGHTS OF WINDOWS OR ACCESS ISSUES PRECLUDE EXTERNA MAINTENANCE INTERNALLY HINGED WINDOW FRAMES WILL BE SPECIFIED FOR CLEANING / MAINTENANCE. IN THE UNLIKELY EVENT THAT A FULL HEIGHT GLAZING PANEL NEEDS TO BE

REPLACED, THE OCCUPIER SHOULD ARRANGE TO DO SO

HAZARD - LINTEL COLUMN & BEAM INSTALLATION CONSTRUCTION LINTELS & BEAMS/STRUCTURAL ELEMENTS TO BE LIFTED INTO PLACE WITH APPROPRIATE EQUIPMENT BY SKILLED

IN ALL CASES - REFER TO CDM RISK REGISTER PROVIDED BY MAIN CONTRACTOR

SOIL VENT PIPE

SHC SMOKE/HEAT/CARDON, MONOXIDE DETECTOR

RAINWATER DOWNPIPE

AUTOMATIC AIR VALVE

MECHANICAL EXTRACT

SMOKE/HEAT/CARBON

DENOTES ASSUMED EXISTING

DENOTES INDICATIVE POSITION OF STRUCTURE OVERHEAD TO STRUCTURAL ENGINEER'S

DETAILS & SPECIFICATION DENOTES SOIL VENT PIPE

DENOTES DEMOLITION LINES

DENOTES MINIMUM 30 MINUTE CAVITY BARRIER - PARTY WALL DENOTES MINIMUM 30 MINUTE

WT08 - EXTERNAL MASONRY WALL GARAGE

COMPLY TO BS EN 13914-1 WITH WATERPROOF 100MM 7.3N DENSE CONCRETE BLOCKS, 1,13 W/M²K 50MM CLEAR RESIDUAL CAVITY
 100MM CONCRETE BLOCKS TO SE SPECIFICATION

STAINLESS STEEL WALL TIES AT 750MM CTS
 HORIZONTALLY, 450MM VERTICALLY AND 225MM CTS
 AT REVEALS AND CORNERS IN STAGGERED ROWS

MASONRY PARTITION USING DENSE CONCRETE BLOCKS BUILT OFF THICKENED FLOOR SLAB WALL TO BE TIED AT 225MM CENTRES WITH

PROPRIETARY STEEL PROFILES OR BLOCK BONDED TO
ALL INTERNAL AND EXTERNAL WALLS WALLS TO BE BUILT WITH 1:1:6 CEMENT MORTAR

WALLS TO BE BUILT WITH 1:1:6 CEMENT MORTAR

WT09 - INTERNAL MASONRY PARTY WALL

DENOTES AS EXISTING SURVEYED DIMENSIONS

DENOTES PROPOSED

CAVITY CLOSER

DENOTES PRODIMENSIONS


DRAINAGE RUNS

DRAINAGE RUNS

TOUGHENED GLASS

ABBREVIATION NOTES:

AAV

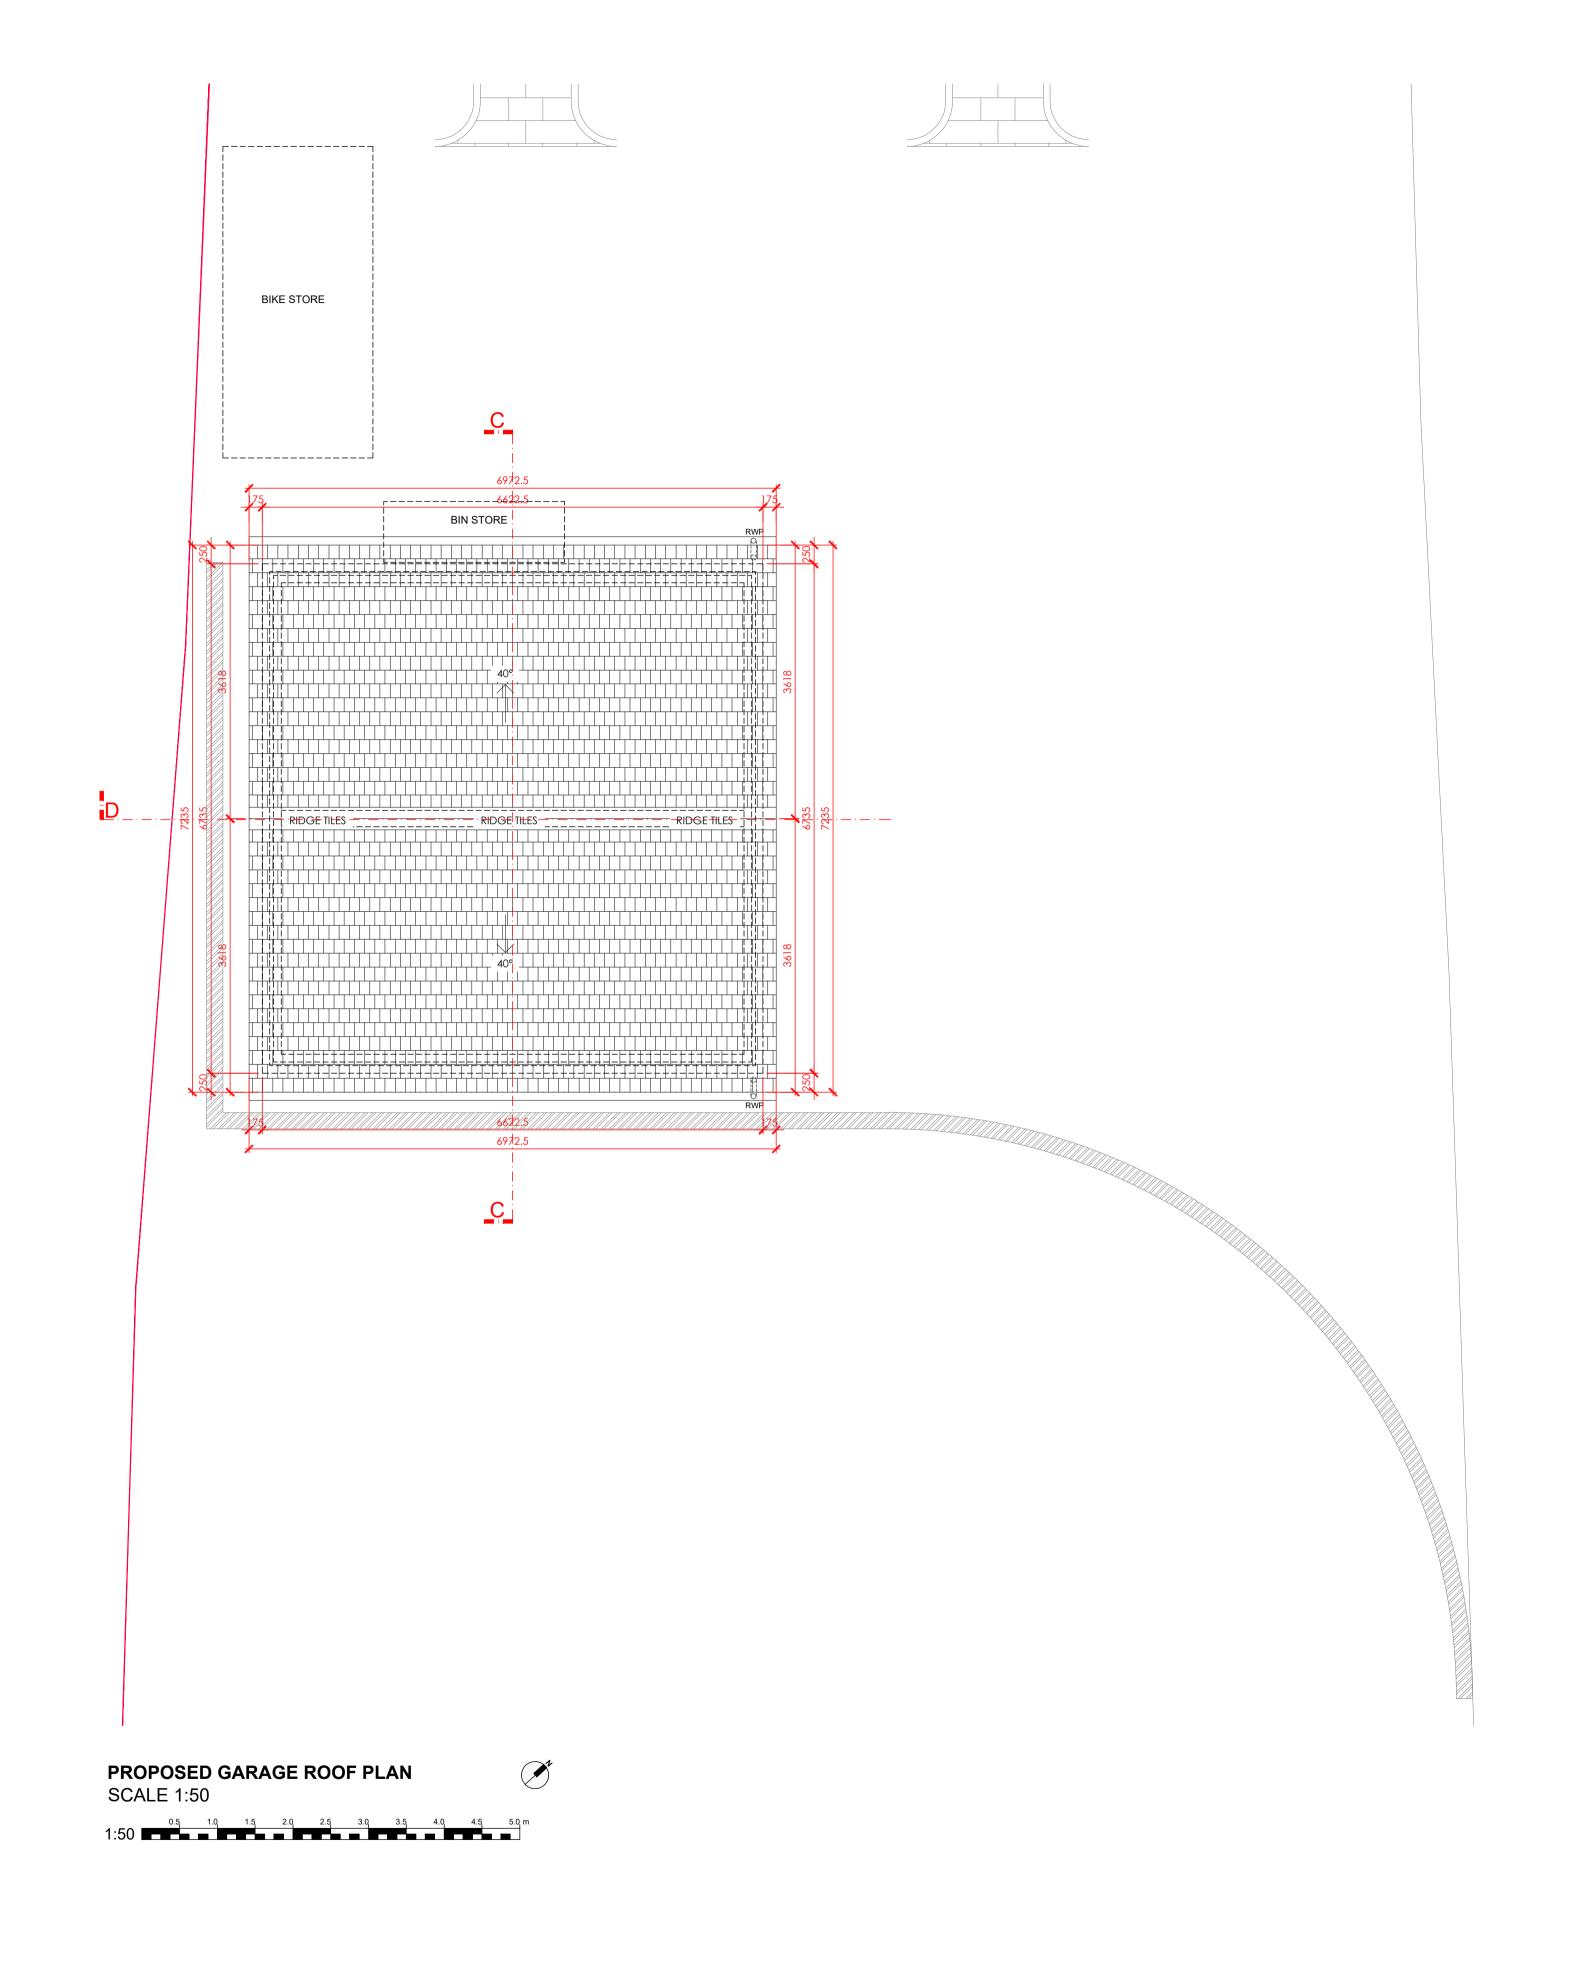

DRAFT - SUBJECT TO REVIEW BY BUILDING CONTROL & STRUCTURAL ENGINEER. TO BE READ IN CONJUNCTION WITH STRUCTURAL ENGINEER'S DOCUMENTATION

MAIN ROOF STRUCTURE:

- ROOF STRUCTURE TO BE DESIGNED BY AN ENGINEER IN ACCORDANCE WITH NHBC TECHNICAL REQUIREMENT R5 STRUCTURAL DESIGN. CALCULATIONS TO BE BASED ON BS EN 1995-1-1:2004 EUROCODE 5: DESIGN OF TIMBER STRUCTURES (+A2:2014). CALCULATIONS AND STRUCTURAL DRAWINGS TO BE SUBMITTED TO BCO FOR APPROVAL.
- GRADE C24 RAFTERS AT MAX 400MM CENTRES, SPAN TO ENGINEER'S DETAILS. RAFTERS SUPPORTED ON 100 X 50MM SW WALL PLATES

ROOF COVERING:

- NATURAL GREY SLATE ROOFING TILES
- 25 x 38MM TANALISED SW TREATED BATTENS
- KINGSPAN NILVENT BREATHABLE MEMBRANE • FINISH UNDERSIDE WITH 2 x LAYERS OF 15MM GYPROC FIRELINE BOARD
- EAVES AND RAINWATER GOODS
- 25MM SW TREATED FASCIA DEEPFLOW UPVC RAINWATER GUTTER AND ASSOCIATED STOP ENDS, CORNERS, OUTLETS AND FIXING
- 68MM UPVC DIA RAINWATER DOWNPIPES AND ASSOCIATED FIXING BRACKETS AT LOCATIONS SHOWN
- ON THE DRAWINGS

BUILDING REGULATIONS

THIS DOCUMENT DOES NOT CONSTITUTE A WORKING DRAWING AND HAS BEEN PREPARED FOR PRICING & BUILDING REGULATIONS APPROVAL ONLY. NO LIABILITY IS ACCEPTED FOR ANY LOSS OF ANY SORT OR ADDITIONAL EXPENSE INCURRED CONSEQUENT ON ANY FAILURE, REAL OR ALLEGED, OF THE DRAWINGS AND SPECIFICATION.

SPECIALIST SUPPLIERS/SUBCONTRACTORS TO SUBMIT DRAWINGS AND DETAILS TO FREDRICK ADAM ARCHITECTS FOR APPROVAL PRIOR TO MANUFACTURE/CONSTRUCTION

do not scale from drawings. Work to figured dimensions. All DIMENSIONS ARE TO BE CHECKED ON SITE PRIOR TO FABRICATION OF COMPONENTS / SETTING OUT. REPORT ANY DISCREPANCIES TO FREDRICK ADAM IMMEDIATELY.

LAND TO THE REAR OF DEERHURST Mr and Mrs P Wheeler

The Shrave Four Marks, Hampshire, GU34 5BH

REVISION DATE DESCRIPTION

PROJECT NO: FA-R-20-17 MODEL FILE:

HBR DRAWN BY: TAD CHK'D BY:

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SHEET TITLE

B011 Garage Roof Plan

FA-R-20-17

Scale: 1: 50 @ A1

